



REVISIONS

4

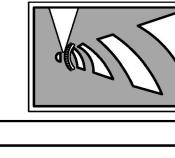

T TH CA GR.

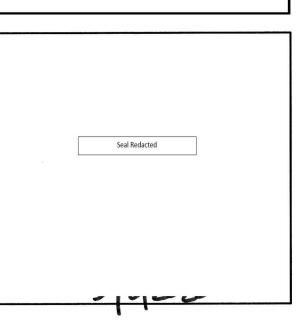



CLIENT INFORMATION:


CLOS PROPERTIES, LLC SHANE HEFFERNAN 255 OLD EASTWOOD ROAD WILMINGTON, NC 28403 (910) 202-4662

DRAWN:	JAE	SHEET SIZE:	24 X 36
CHECKED:	CDC	DATE:	9/3/2020
APPROVED:	CDC	SCALE:	1" = 40'
PROJECT NUMBER:		2019-027	

DRAWING NUMBER: C-o

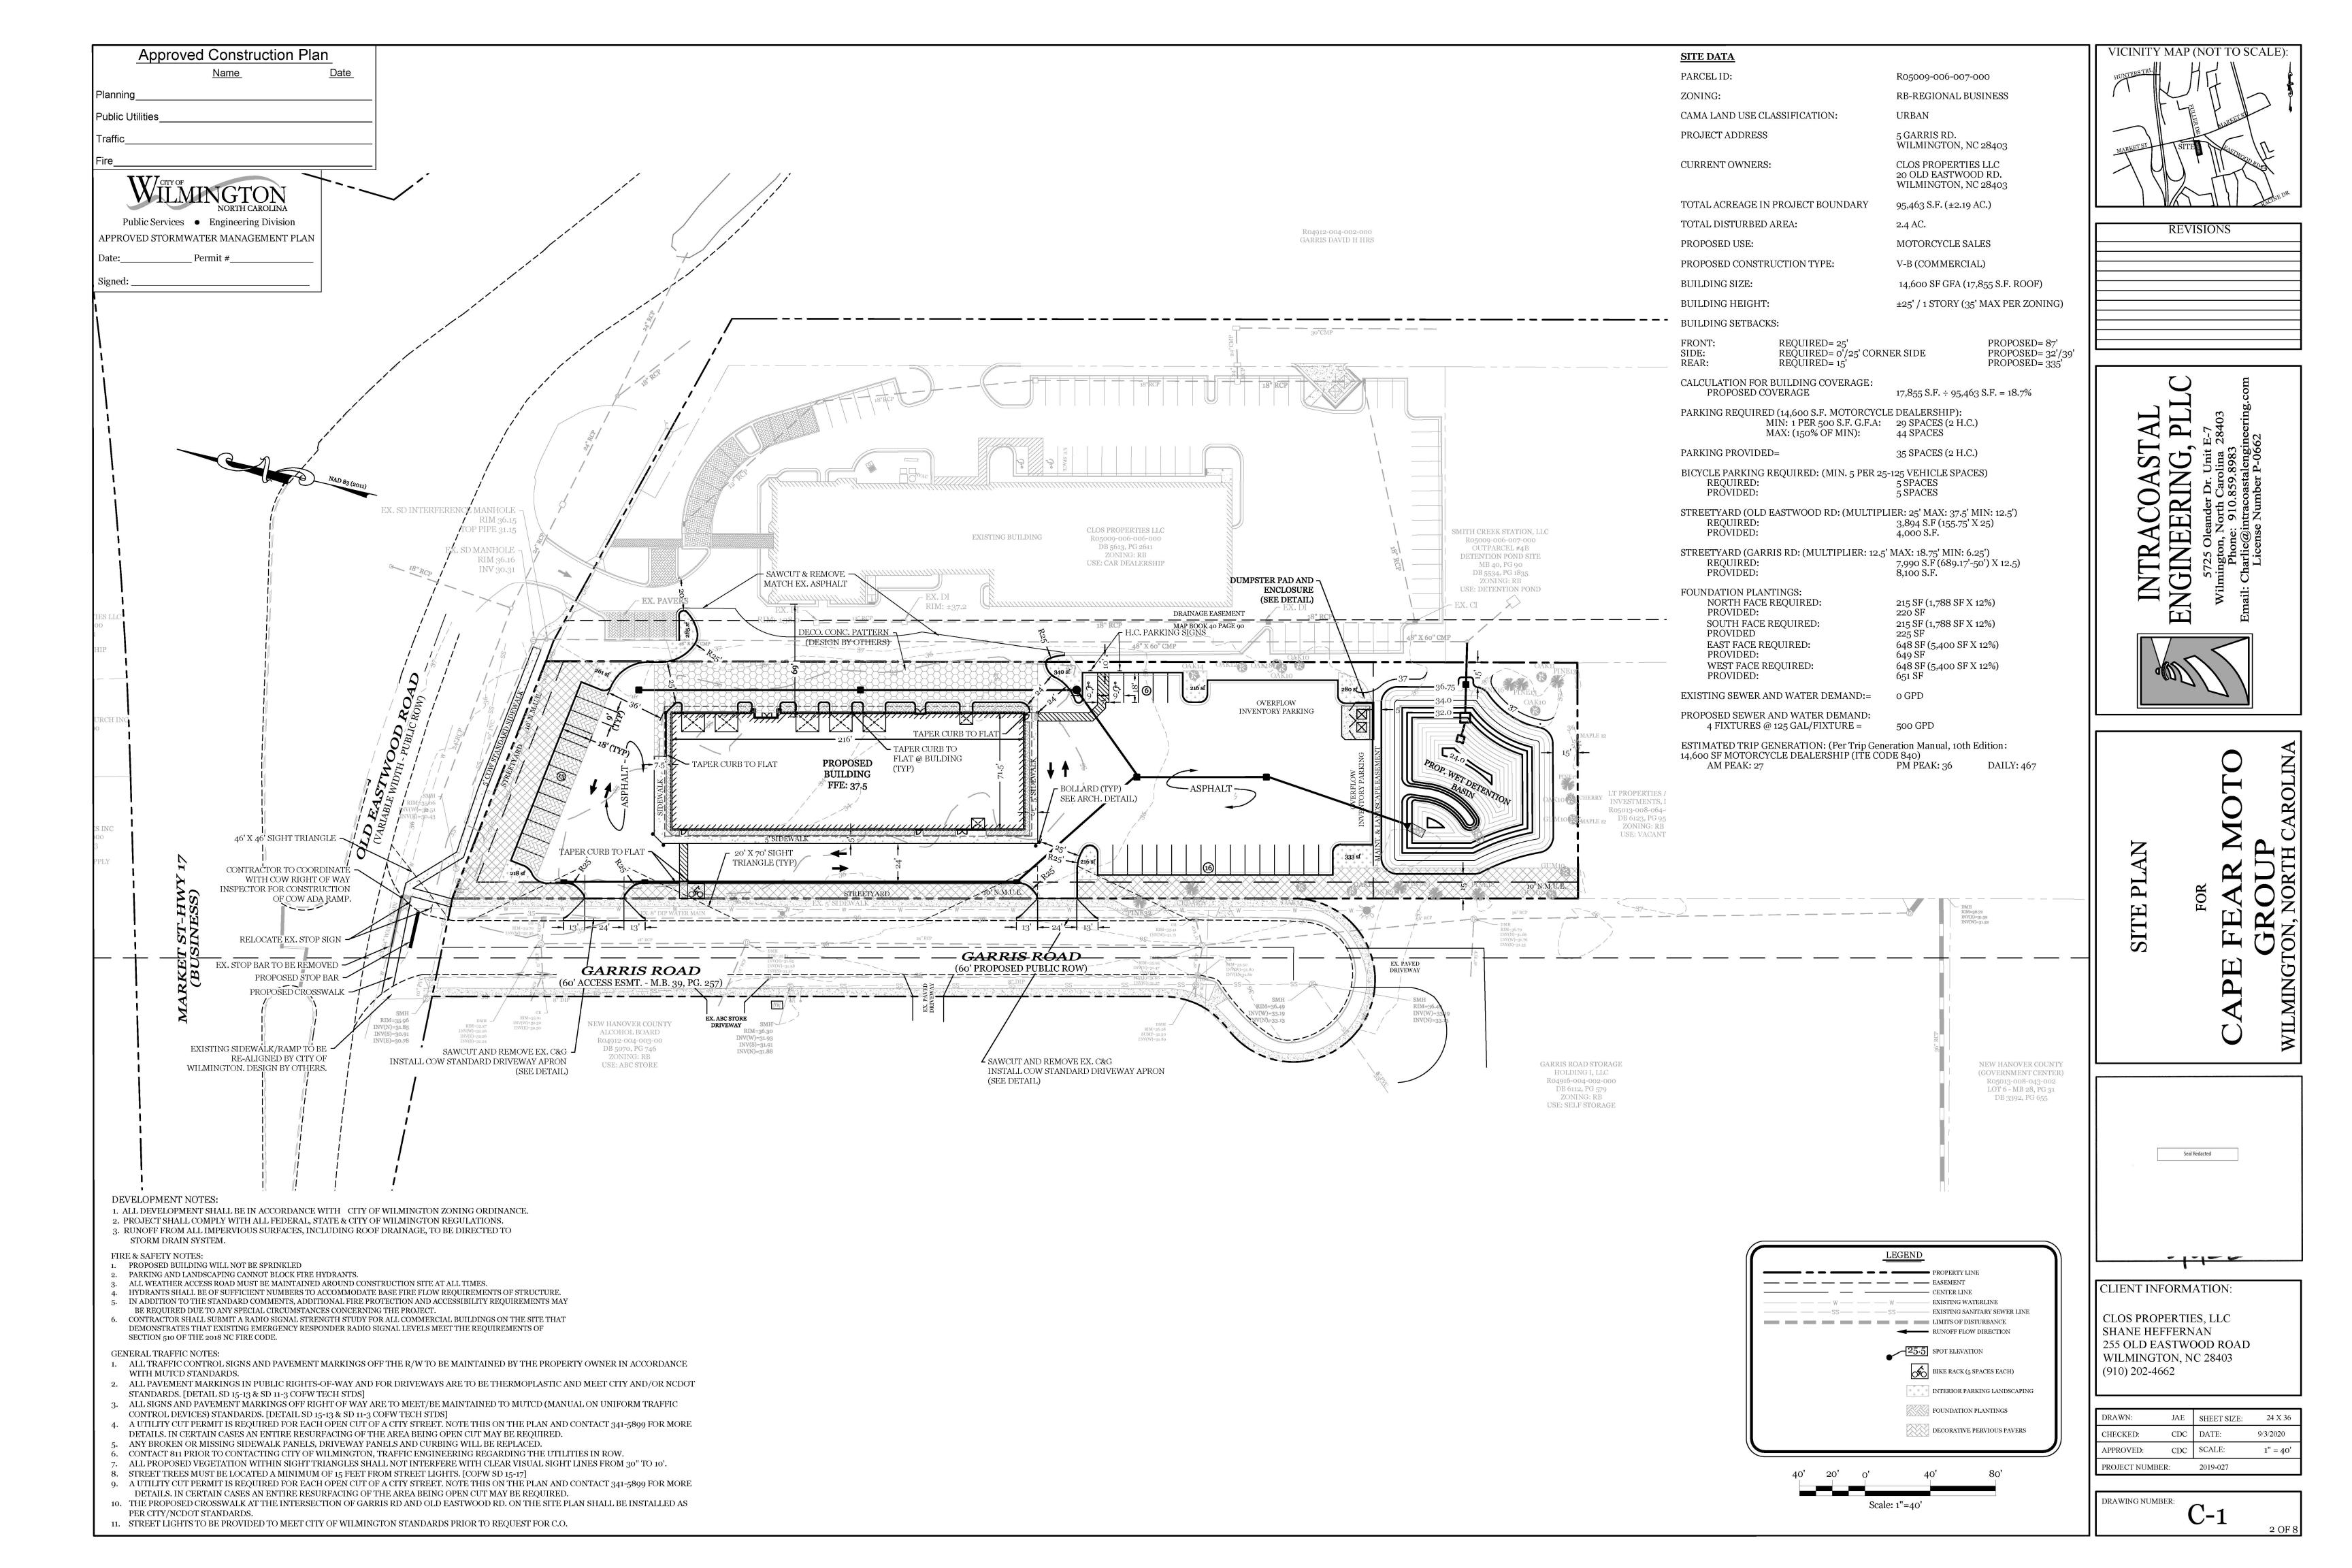

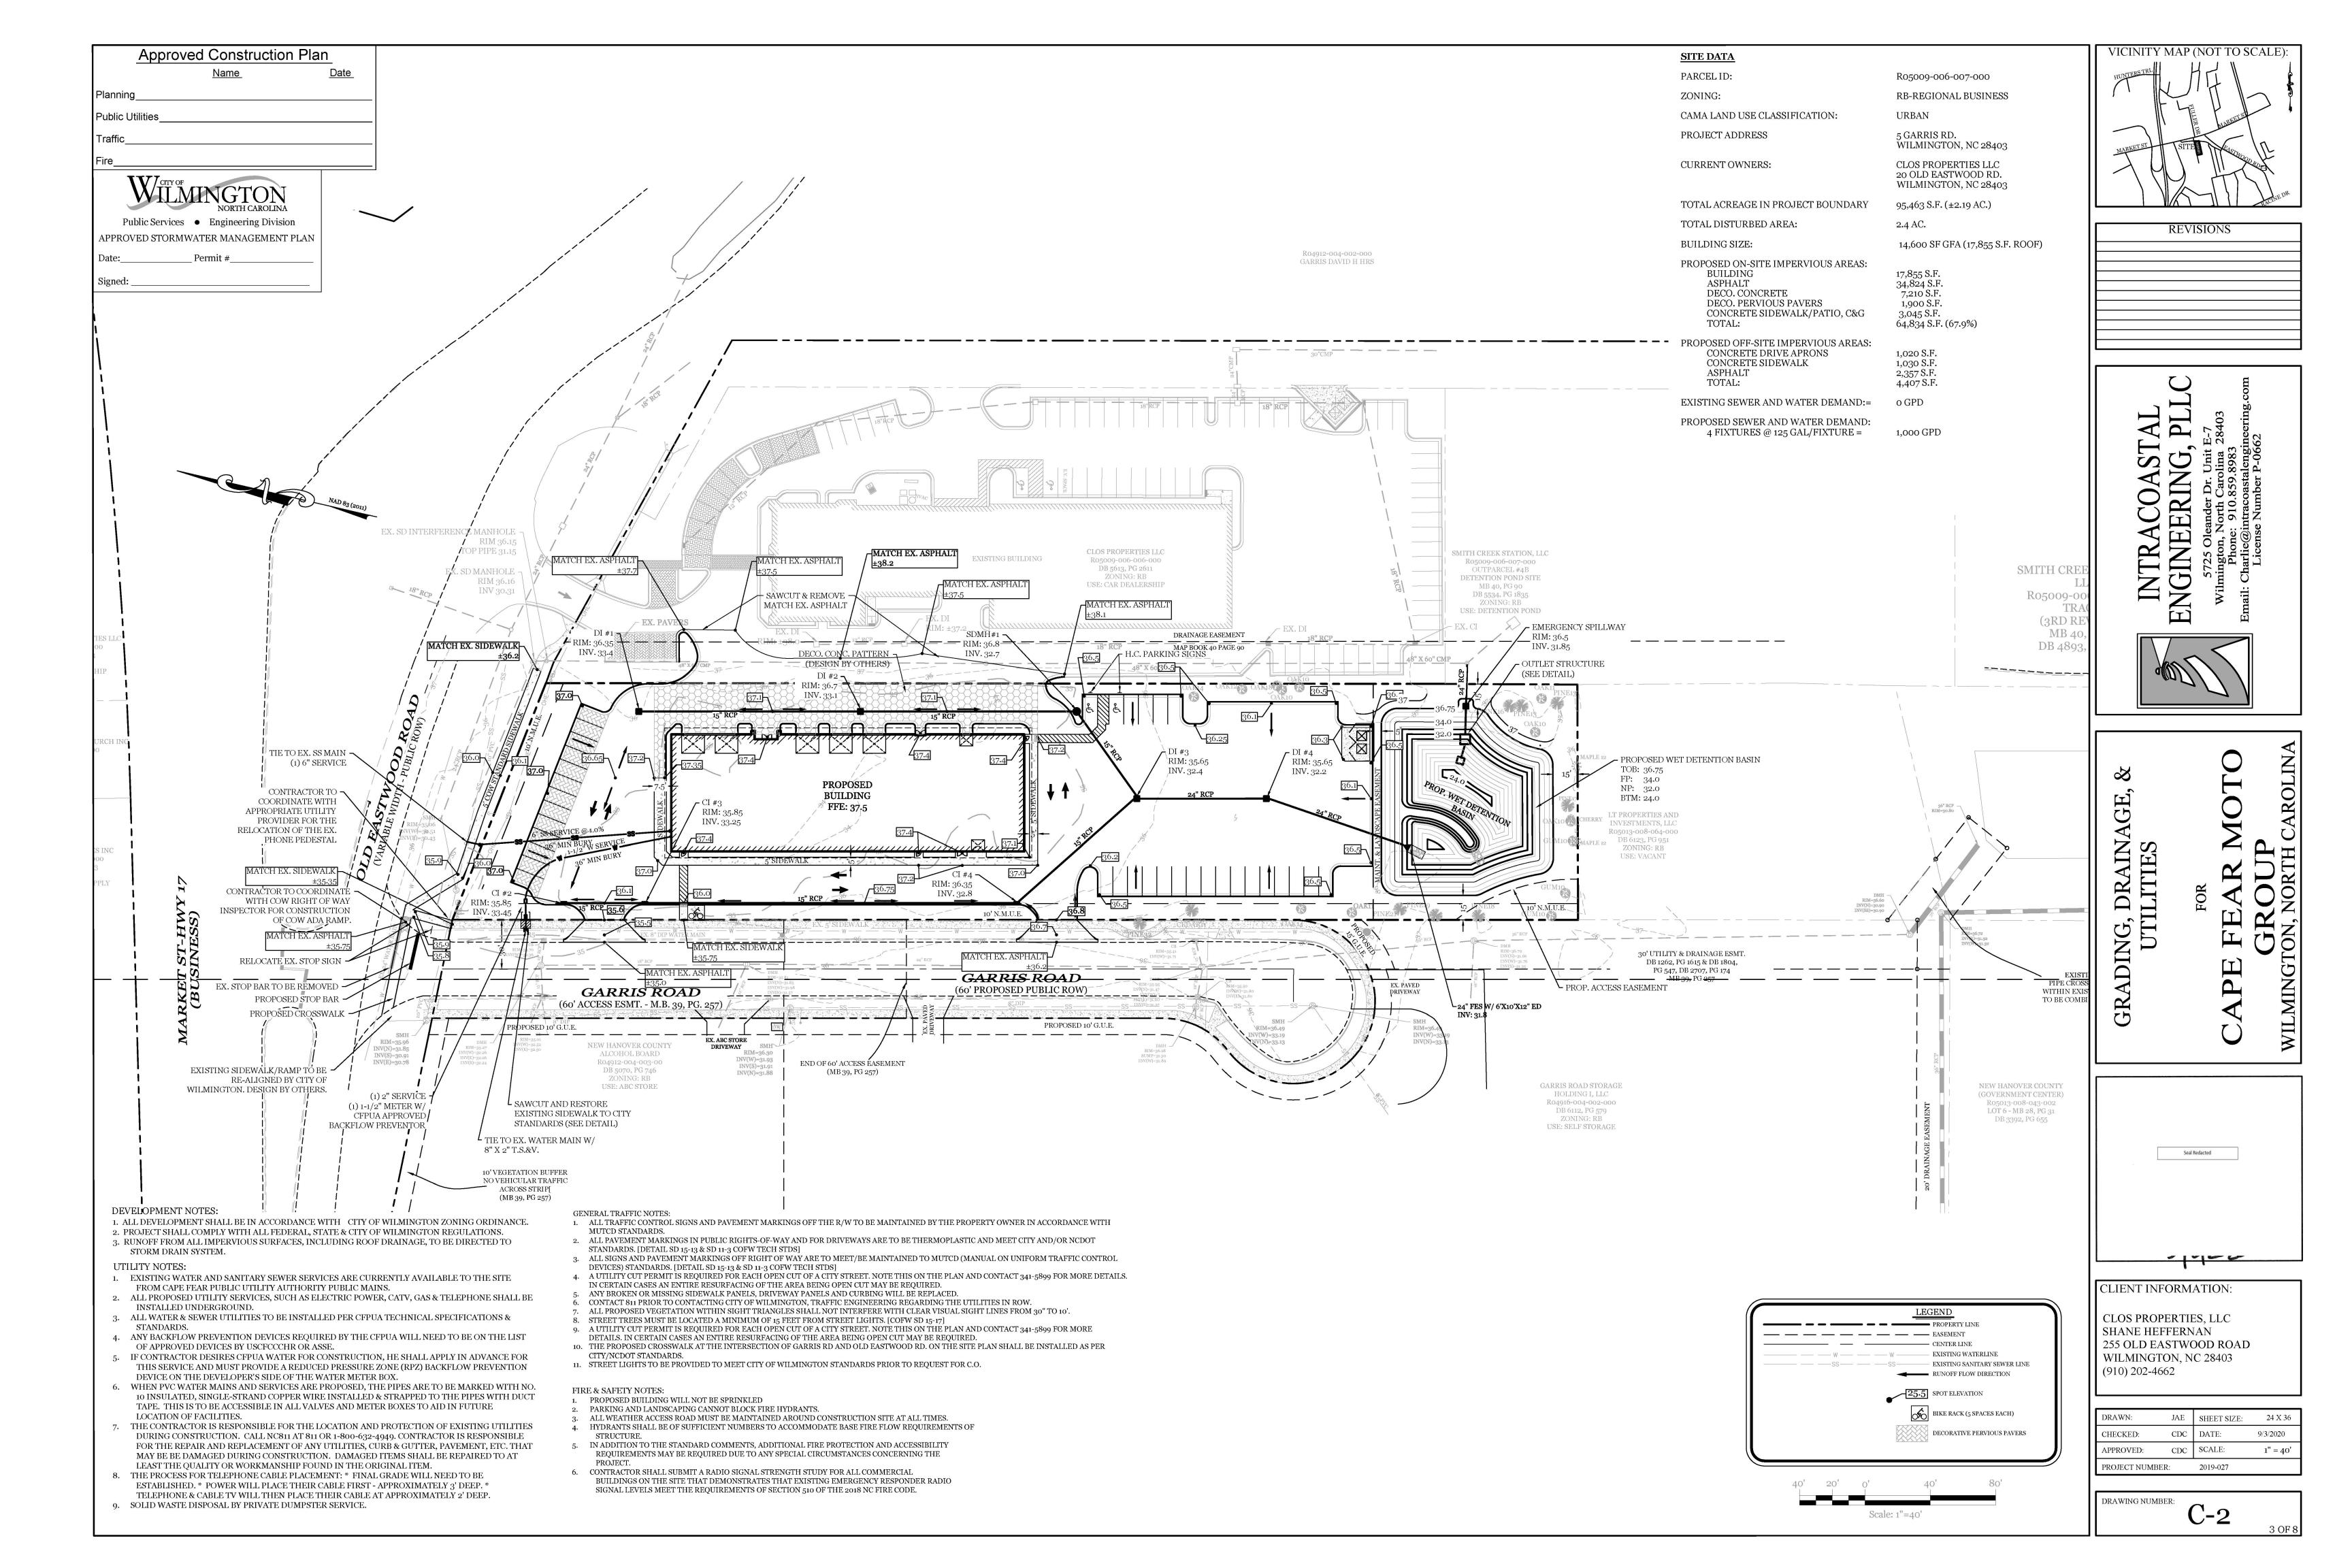

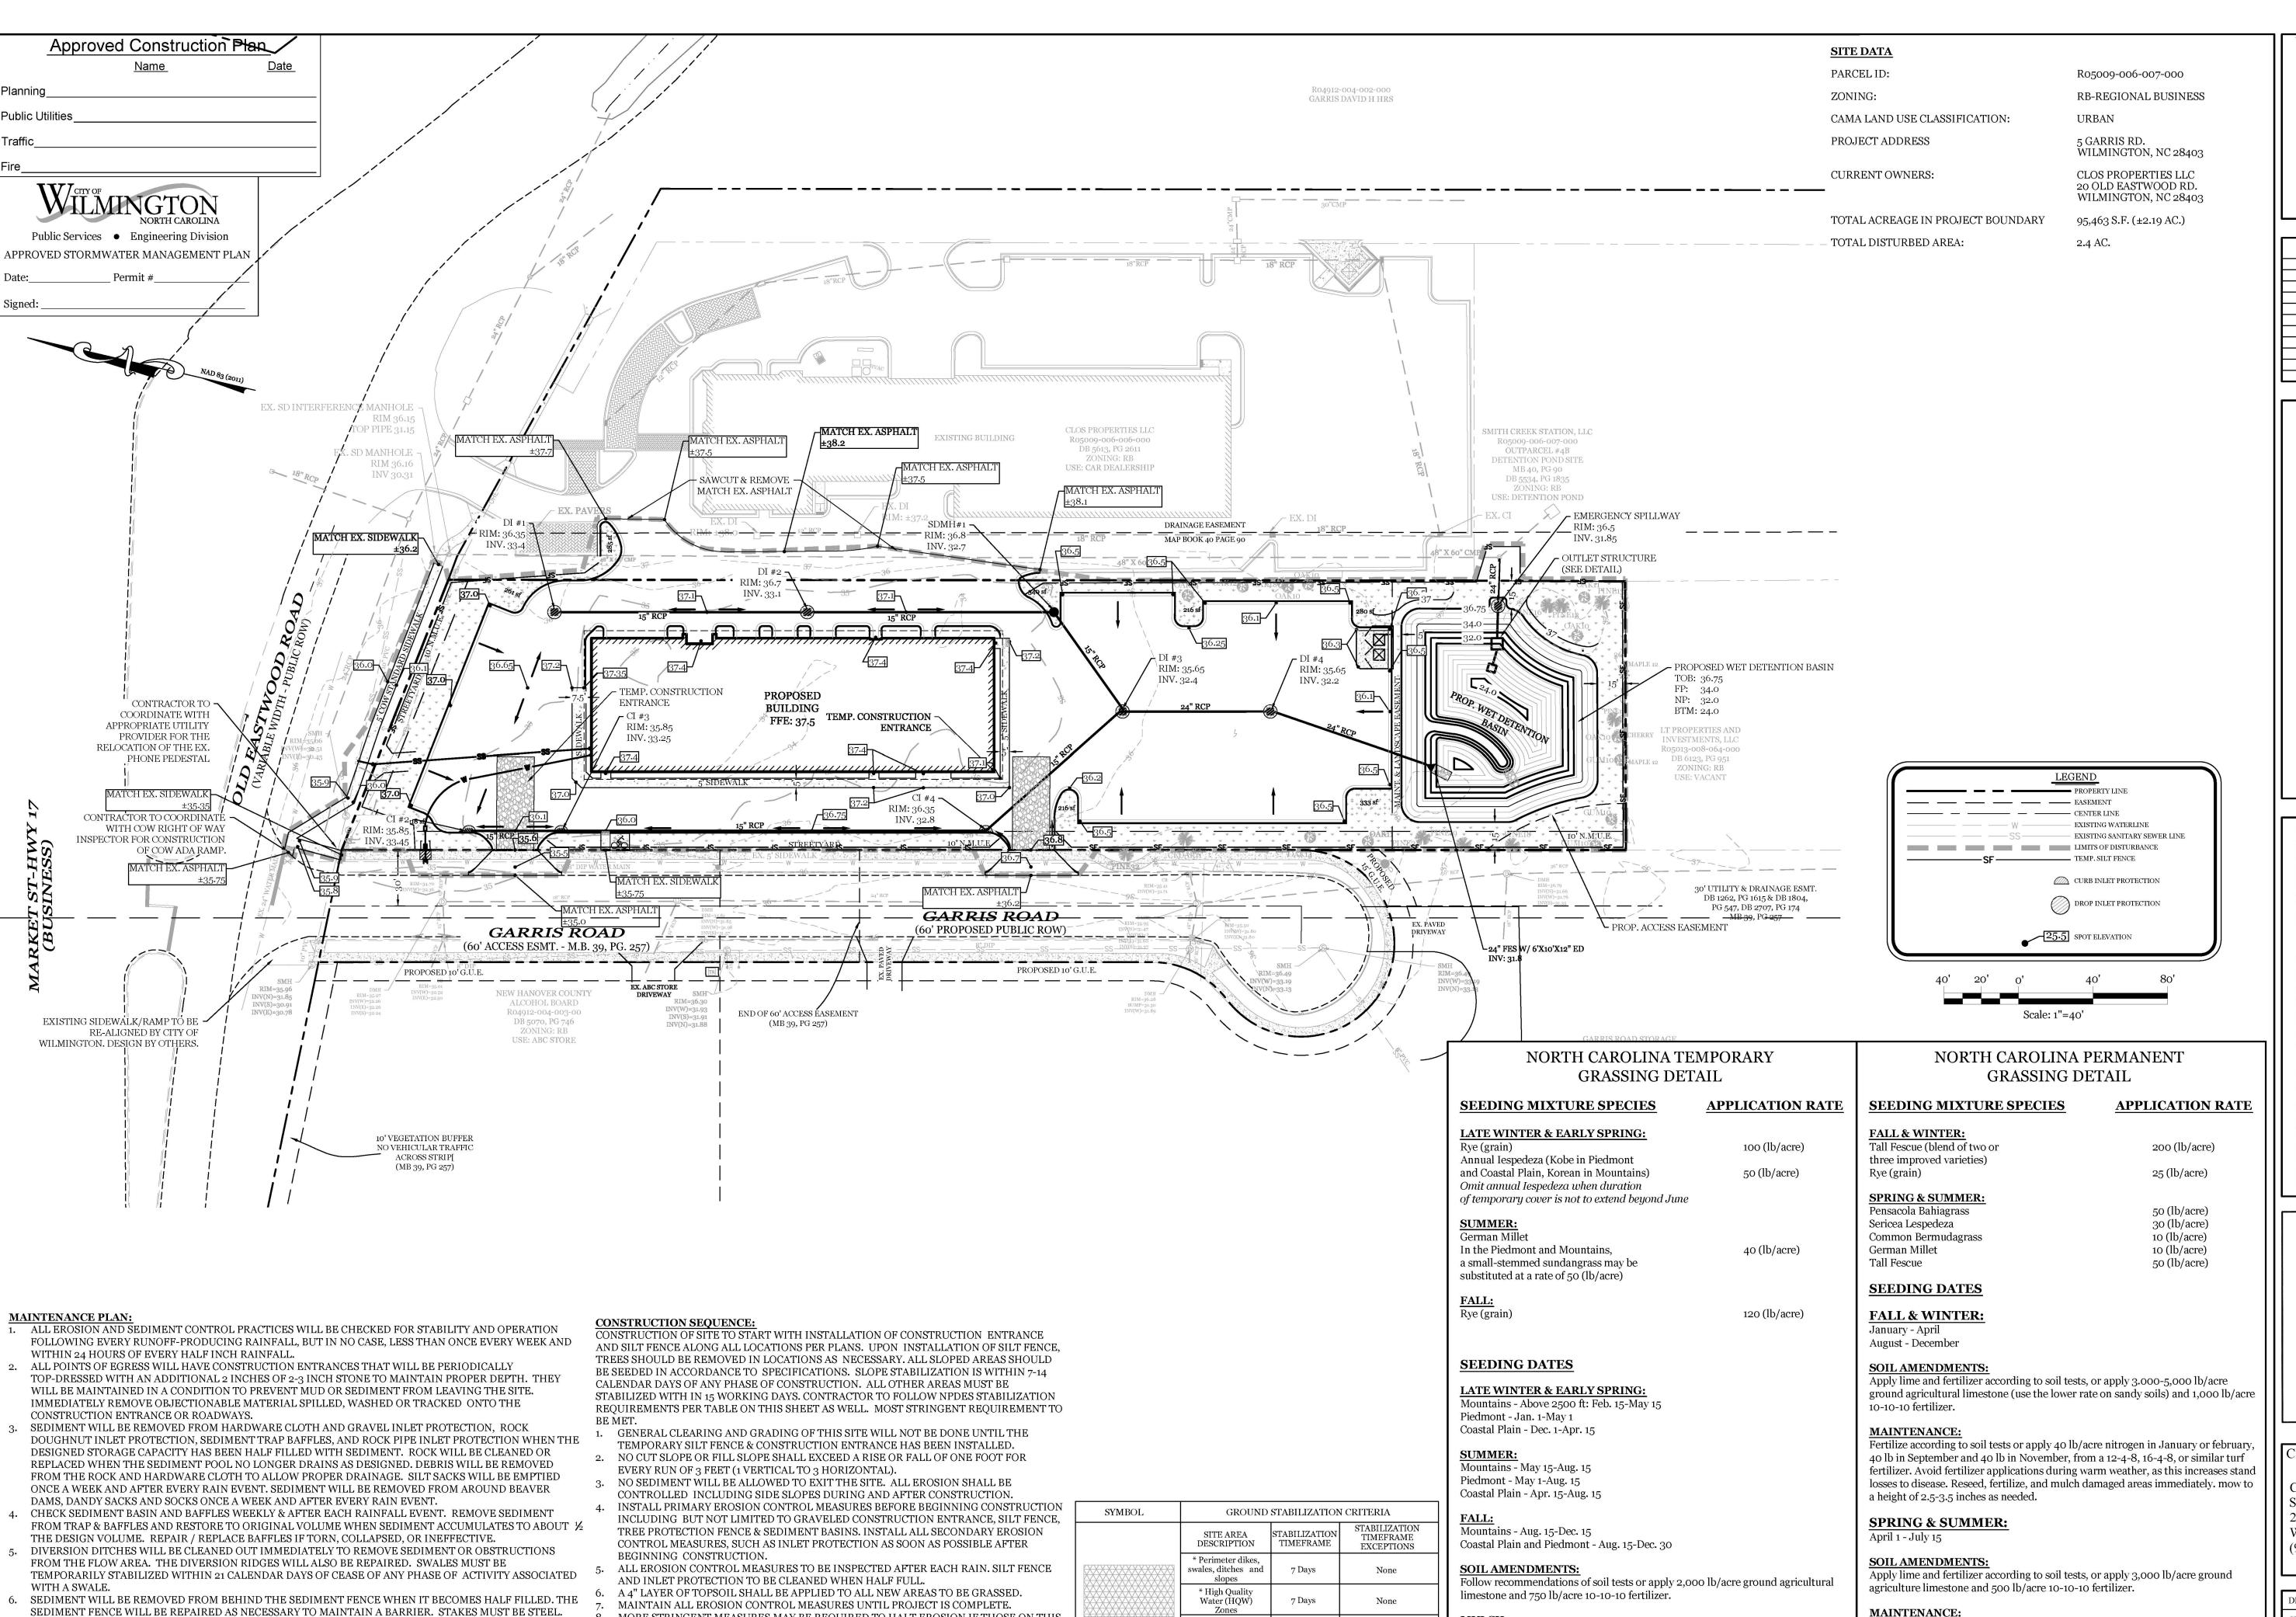

If slopes are 10' 01

less in length and

are not steeper tha

2:1, 14 days are allowed

7-days for slopes

greater than 50 ft. in

None (except for

perimeters & HQW

* Slopes Steeper

Slopes 3:1 or flatter

* All other areas with

slopes flatter than 4:1

apply 4,000 lb/acre straw. anchor straw by tacking with asphalt, netting, or a

mulch anchoring tool. A disk with blades set nearly straight can be used as a mulch

Refertilize if growth is not fully adequate. reseed, refertilize and mulch immediately

following erosion or other damage.

8. MORE STRINGENT MEASURES MAY BE REQUIRED TO HALT EROSION IF THOSE ON THIS

CONSTRUCTION. ALL PERMANENT MEASURES SHALL BE WELL ESTABLISHED PRIOR TO

REMOVE ALL TEMPORARY EROSION CONTROL MEASURES UPON COMPLETION OF

PLAN PROVE TO BE LESS EFFECTIVE.

PROJECT COMPLETION.

STAKE SPACING WILL BE 6 FEET MAX. WITH THE USE OF EXTRA STRENGTH FABRIC, WITHOUT WIRE

WILL BE REPAIRED OR REPLACED IF IT BECOMES HALF FULL OF SEDIMENT, NO LONGER DRAINS AS

AND DEBRIS TO RESTORE FLOW TO ORIGINAL STATE.

BACKING. STAKE SPACING WILL BE 8 FEET MAX WHEN STANDARD STRENGTH FABRIC AND WIRE BACKING


ARE USED. IF ROCK FILTERS ARE DESIGNED AT LOW POINTS IN THE IN THE SEDIMENT FENCE THE ROCK

FAIRCLOTH SKIMMER TO BE ROUTINELY CHECKED FOR SEDIMENT ACCUMULATION, TRASH, AND DEBRIS


CLOGGING THE WATER ENTRY ORIFICES. PULL SKIMMER TO SIDE OF BASIN AND HAND REMOVE SEDIMENT

VICINITY MAP (NOT TO SCALE)

REVISIONS

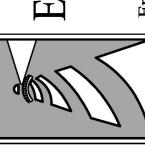

ER AN

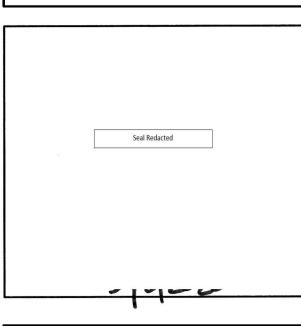

CLIENT INFORMATION:

CLOS PROPERTIES, LLC

SHANE HEFFERNAN 255 OLD EASTWOOD ROAD WILMINGTON, NC 28403 (910) 202-4662

DRAWN:	JAE	SHEET SIZE:	24 X 36
CHECKED:	CDC	DATE:	9/3/2020
APPROVED:	CDC	SCALE:	1" = 40'
PROJECT NUMBER:		2019-027	

DRAWING NUMBER:

Refertilize the following april with 50 lb/acre nitrogen. Repeat as growth requires.

may be moved only once a year. Where a neat appearance is desired, omit sericea


apply 4,000 lb/acre straw. anchor straw by tacking with asphalt, netting, or a

mulch anchoring tool. A disk with blades set nearly straight can be used as a mulch

and mow as often as needed.

anchoring tool.


C-3

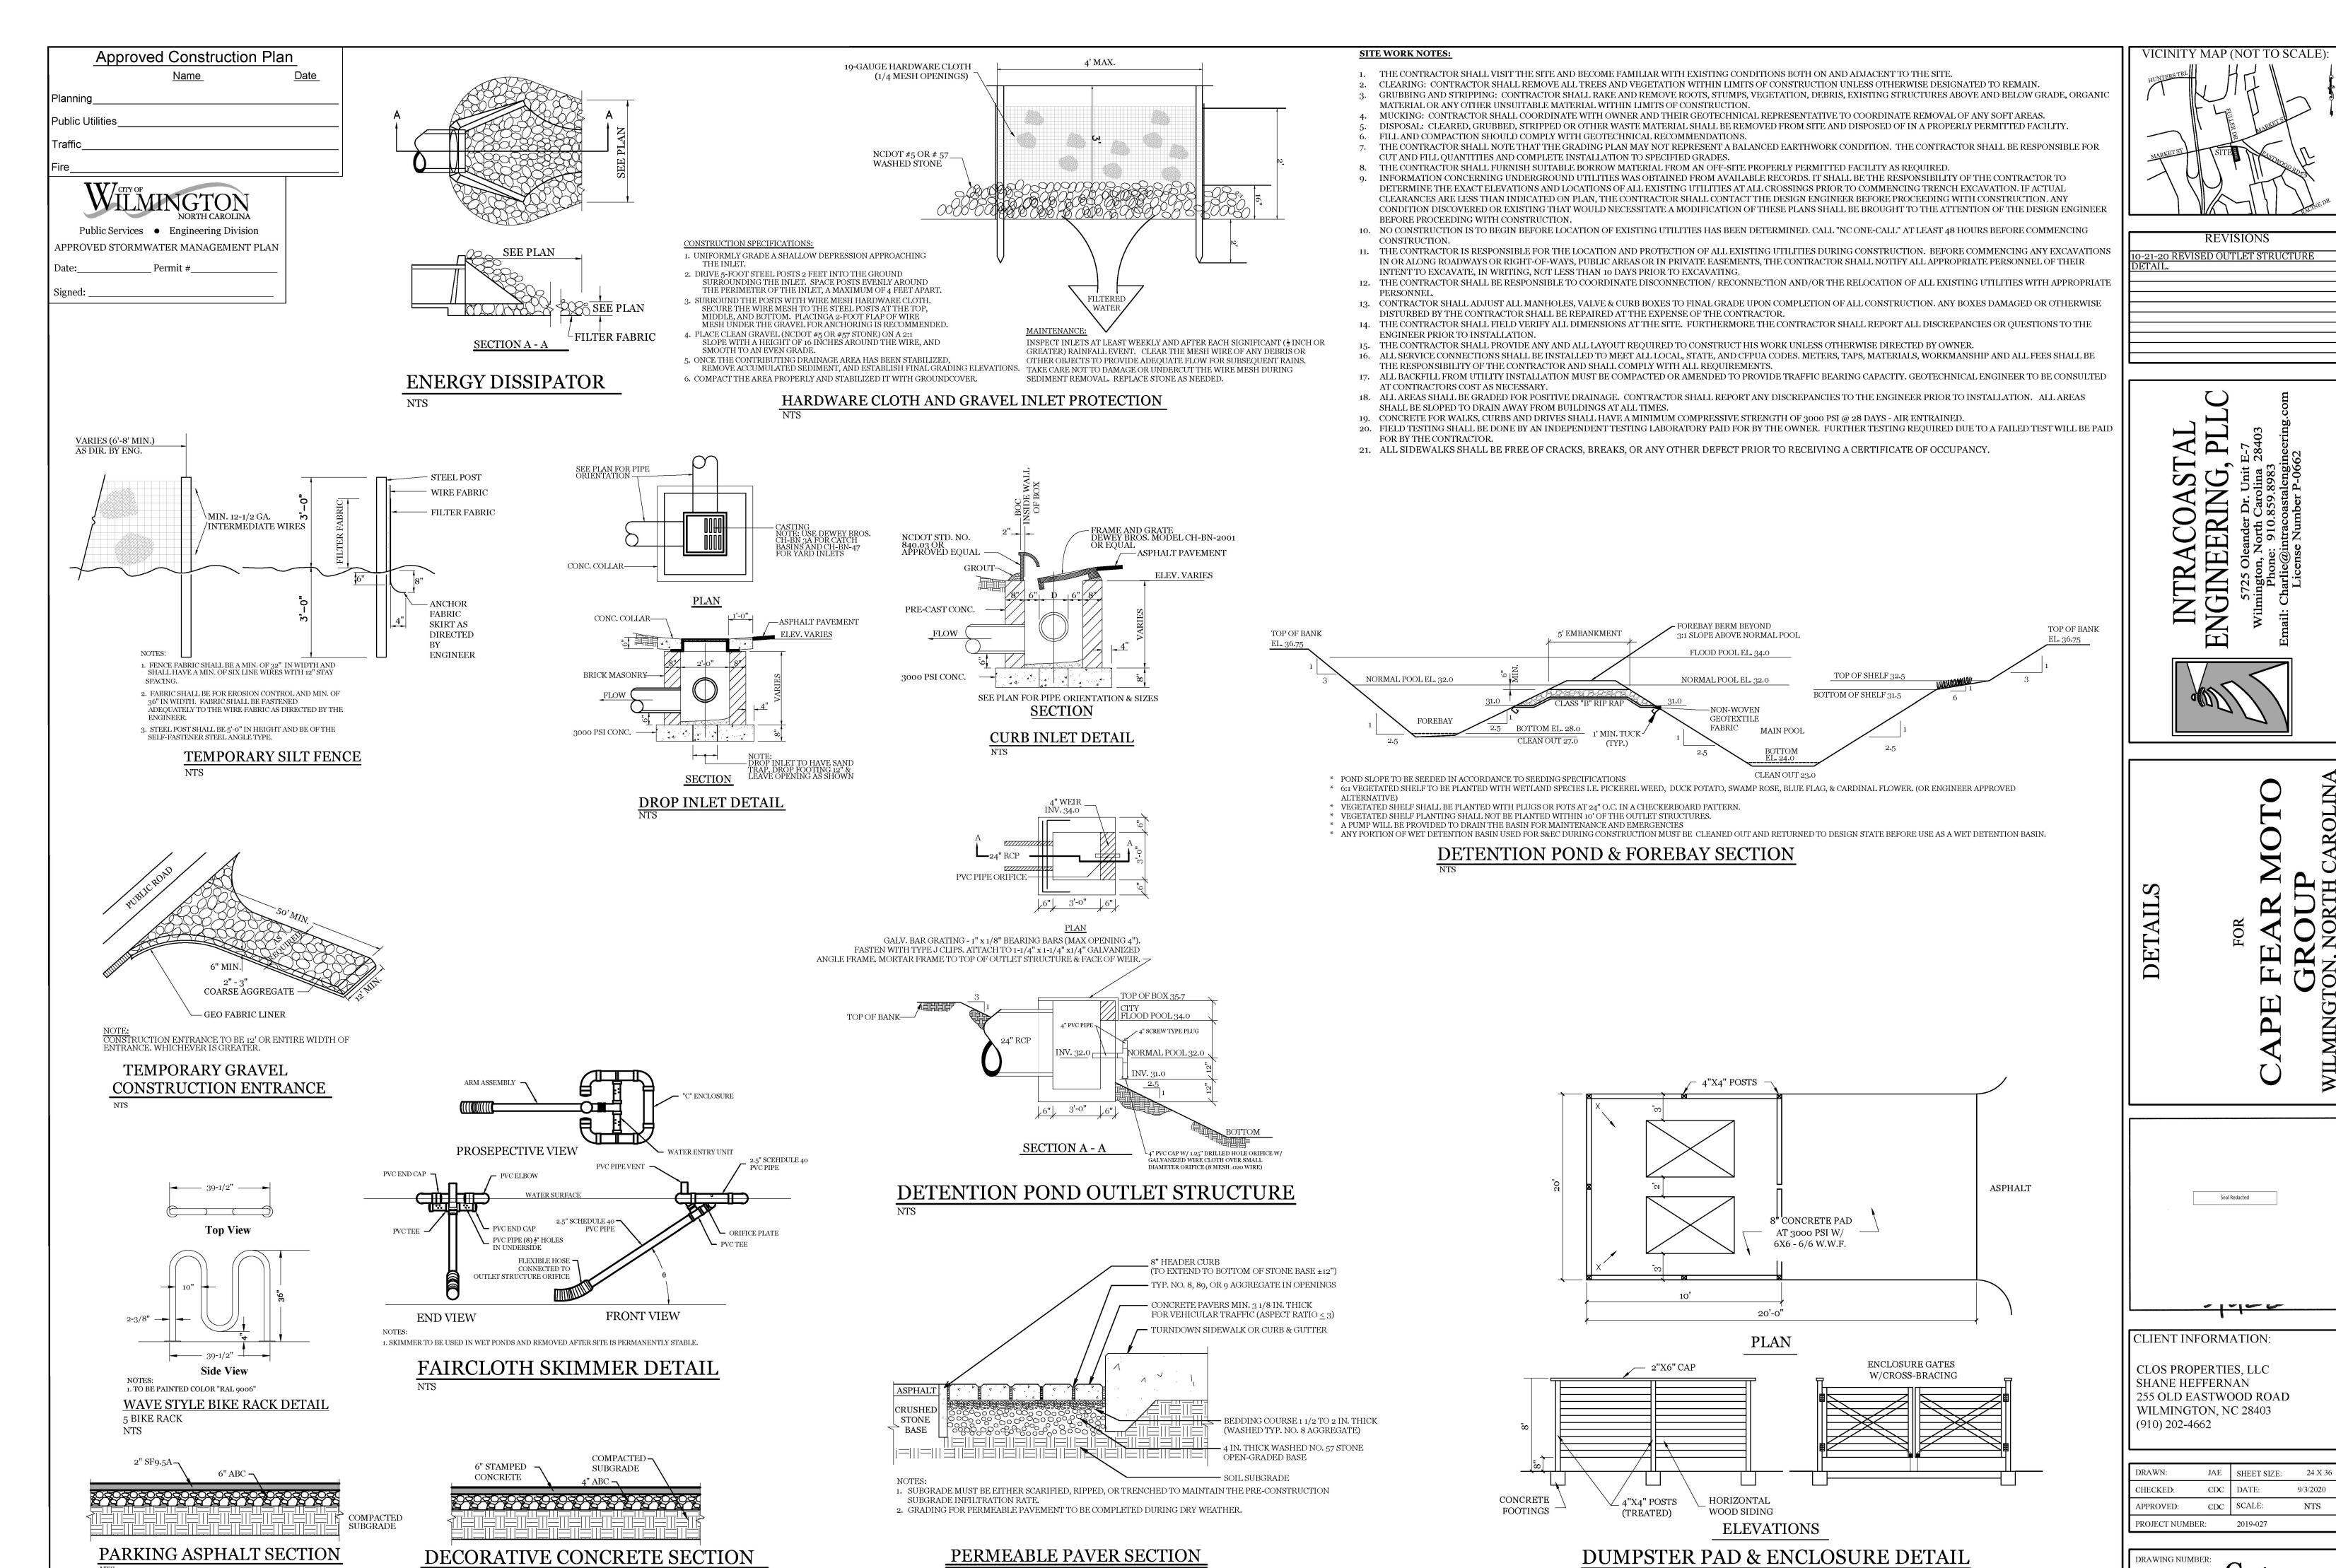


C-4

9/3/2020


NTS

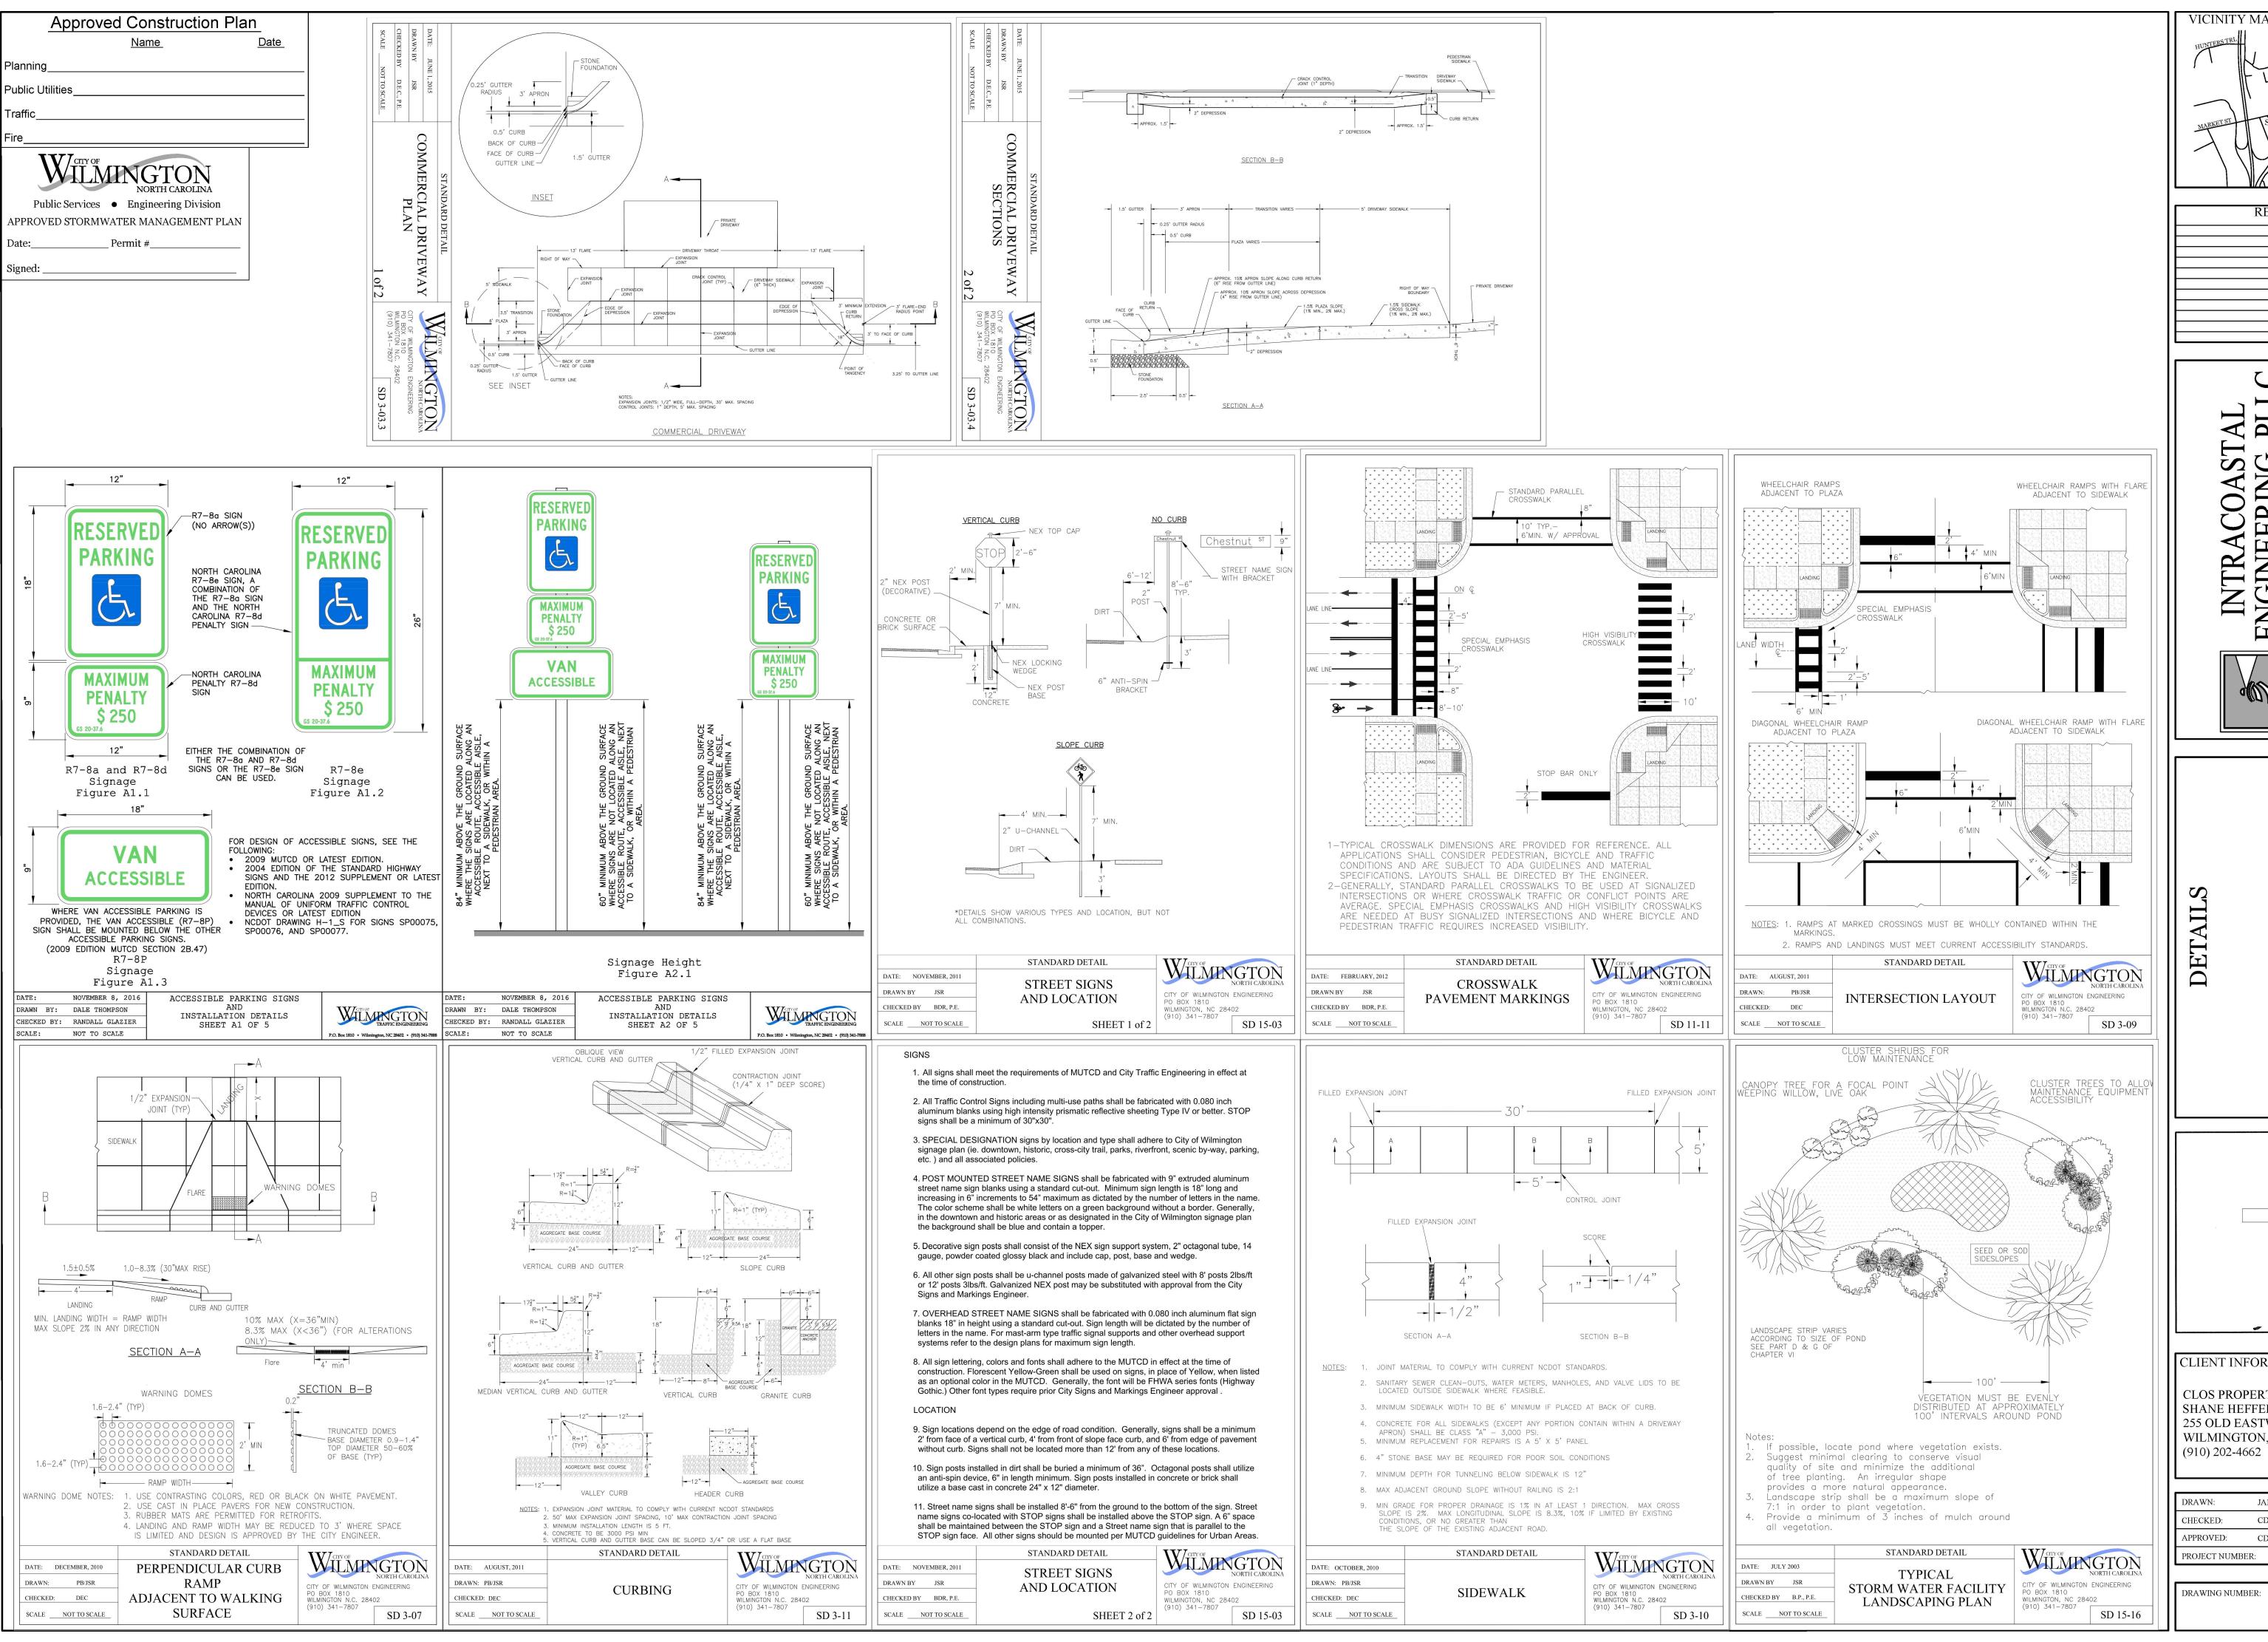

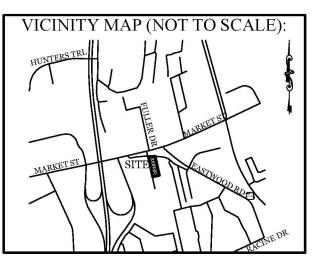


REVISIONS

PL INTRACOAS INGINEERIN

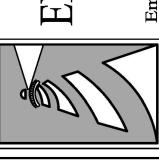

V

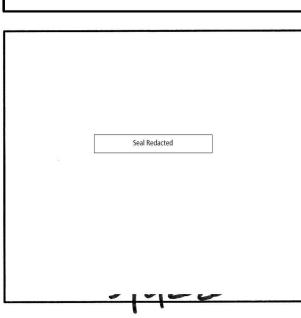


CLIENT INFORMATION:

CLOS PROPERTIES, LLC SHANE HEFFERNAN 255 OLD EASTWOOD ROAD WILMINGTON, NC 28403


DRAWN:	JAE	SHEET SIZE:	24 X 36
CHECKED:	CDC	DATE:	9/3/2020
APPROVED:	CDC	SCALE:	NTS
PROJECT NUMBER:		2019-027	


DRAWING NUMBER:

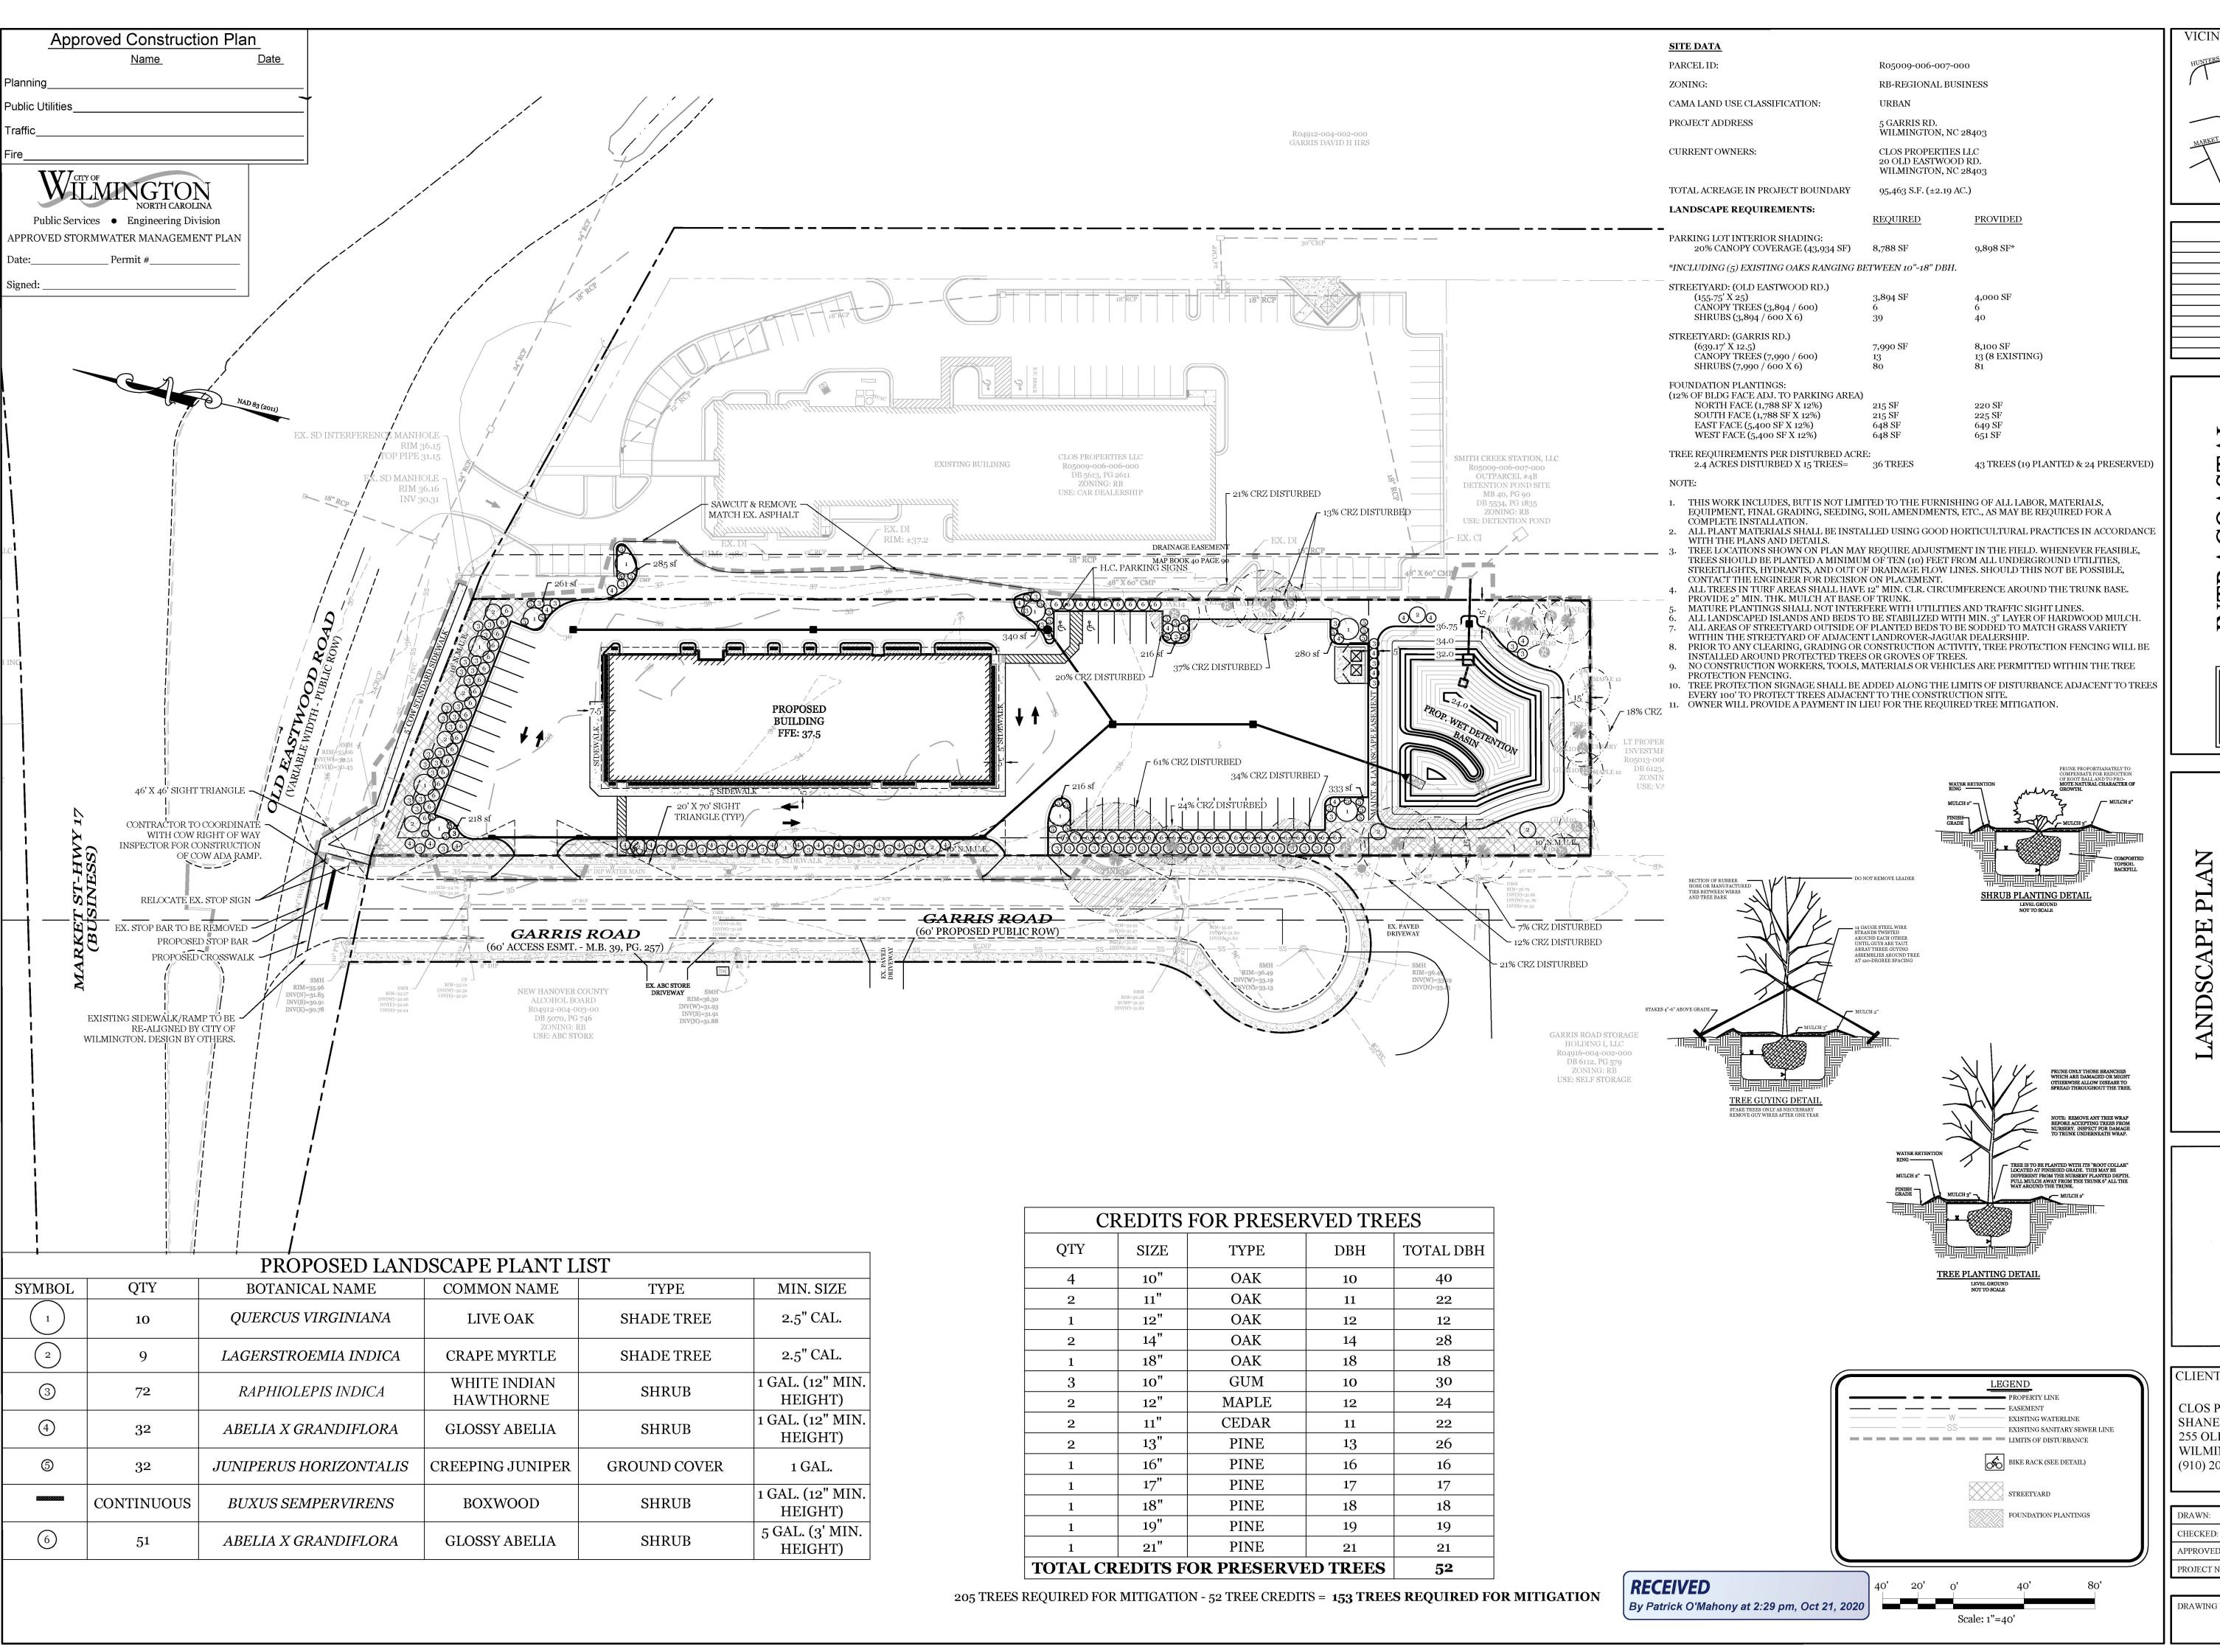

REVISIONS

Î

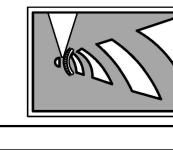

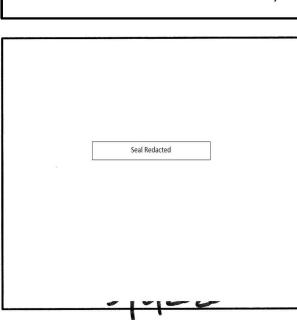

CLIENT INFORMATION:

CLOS PROPERTIES, LLC SHANE HEFFERNAN 255 OLD EASTWOOD ROAD WILMINGTON, NC 28403 (910) 202-4662

DRAWN:	JAE	SHEET SIZE:	24 X 36
CHECKED:	CDC	DATE:	9/3/2020
APPROVED:	CDC	SCALE:	1" = 40'
PROJECT NUMBER:		2019-027	

DRAWING NUMBER: L-1